COUNTY OF RIVERSIDE STREET IMPROVEMENTS CUP 03370

CAJALCO EXPRESSWAY AND HARVILL AVENUE


GENERAL

DIGALERT

W.

800-227-2600

- 10. IT SHALL BE THE RESPONSIBILITY OF THE DEVELOPER/OWNER OR CONTRACTOR
 TO APPLY TO THE RIVESED COUNTY TRANSPORTATION DEPARTMENT, PERMIT
 SECTION, FOR AN ENGROACHMENT PERMIT FOR ALL WORK PERFORMED WITHIN
 PUBLIC MORTO-OWNY DEDOCATED AND ACCEPTED FOR PUBLIC USE; AND TO BE AN
 REQULATIONS DURING THE LIFE OF CONSTRUCTION ACTIVITIES FOR THIS PROJECT.
 ADDITIONAL STUDIES AND/OWN PERMITS MAY DE REQUIRED.
- 1b. PRIOR TO ANY CONSTRUCTION, THE DEVELOPER/OWNER SHALL PROVIDE THAT COUNTY WITH A COPY OF THE NOI, WITH A VALID WOID NUMBER.
- THE CONTRACTOR SHALL BE RESPONSIBLE FOR THE CLEARING OF THE PROPOSED MORK AREA, AND RELOCATION COSTS OF ALL EXISTING UTLITES, PERMITTEE MUST INFORM COUNTY OF CONSTRUCTION SCHEDULE AT LEAST 48 HOURS PRIOR TO BEGINNING OF CONSTRUCTION. PHDN: 1999 955-6790
- ALL WORK SHALL CONFORM TO THE REQUIREMENTS OF THE RIVERSIDE COUNTY TRANSPORTATION DEPARTMENT IMPROVEMENT STANDARDS AND SPECIFICATIONS, LATEST EDITION, COUNTY ORDINANCE NO. 461 AND SUBSEQUENT AMENDMENTS.
- ALL UNDERGROUND FACILITIES, WITH LATERALS, SHALL BE IN PLACE PRIOR TO PAYING THE STREET, INCLUDING, BUT NOT LIMITED TO, THE FOLLOWING: SEWER WATER, ELECTRIC, CAS, STORM DRAINS.
- CURB DEPRESSIONS AND DRIVEWAY APPROACHES WILL BE INSTALLED AND CONSTRUCTED ACCORDING TO COUNTY STANDARD NO. 206 AND/OR NO. 207, AS DIRECTED IN THE FIELD.
- 6. IT SHALL BE THE RESPONSIBILITY OF THE CONTRACTOR TO APPLY TO THE CALFORNA DEPARTMENT OF TRANSPORTATION (CALTRAMS) FOR AN ENGROACHMENT PERMIT FOR ALL WORK PERFORMED WITHIN THE STATE RIGHT-OF-WAY.
- 7. IT SHALL BE THE RESPONSIBILITY OF THE CONTRACTOR TO INSTALL AND MANTAN ALL CONSTRUCTION, REGULATORY, CUDE AND WARNING SIGNS WITHIN THE PROJECT LIMITS AND ITS SURROUNDINGS TO PROVIDE SAFE PASSAGE FOR THE TRAVELING PUBLIC AND WORKERS UNTIL FINAL COMPLETION AND ACCEPTANCE OF THE PROJECT BY THE COUNTY.
- STREET LIGHTS SHALL BE INSTALLED IN ACCORDANCE WITH THE APPROVED STREET LIGHTING PLAN.
- 9. ANY PRIVATE DRAINAGE SHOWN ON THESE PLANS IS FOR INFORMATION ONLY. BY SIGNING THESE IMPROVEMENT PLANS, NO REVIEW OR APPROVAL OF THESE PRIVATE FACILITIES IS MPLIED OR INTENDED BY THE RIVERSIDE COUNTY TRANSPORTATION DEPARTMENT.
- CONSTRUCTION PROJECTS DISTURBING MORE THAN ONE ACRE MUST OBTAN A NATIONAL POLLUTIANT DISCHARGE ELIMINATION SYSTEM (MPDES) PERMIT, OWNERS/DEVLICPERS ARE ROUNGED TO FILE A NOTICE OF INTENT (MO) WITH HE STATE WATER RESOURCES CONTROL BOARD ISWARDS, PREPARA A STORM, STIEL.
- THE DEVELOPER SHALL BE RESPONSIBLE FOR THE INSTALLATION OF ADDITION SIGNS AND MARKINGS NOT INCLIDED IN THE SIGNAL AND STRIPING POLION WITHIN THE PROJECT AREAS, OP ON ROADWAYS ADJACENT TO THE PROJECT BOUNDARIES, UPON THE REQUEST OF THE DIRECTOR OF TRANSPORTATION OR HIS DESIGNEE TO MERGOVE TRAFFIC SAFETY ON THE ROADS SUINCET TO.
- PRIOR TO ANY CONSTRUCTION, THE DEVELOPER SHALL PROVIDE THE COUNTY A COPY OF THE NOI WITH A VALID WIDID NUMBER.
- 13. EXISTING STORM DRAIN PIPES/CULVERTS (WHETHER TO BE CONNECTED TO, EXTENDED, ADJUSTED, DRAINED TO, OR JUST IN THE PROJECT VICINITY) MUST BE REPAIRED, AND/OR CLEANED TO MAKE THEM FUNCTIONAL AND ACCEPTABLE AS DIRECTED BY THE TRANSPORTATION DEPARTMENT.

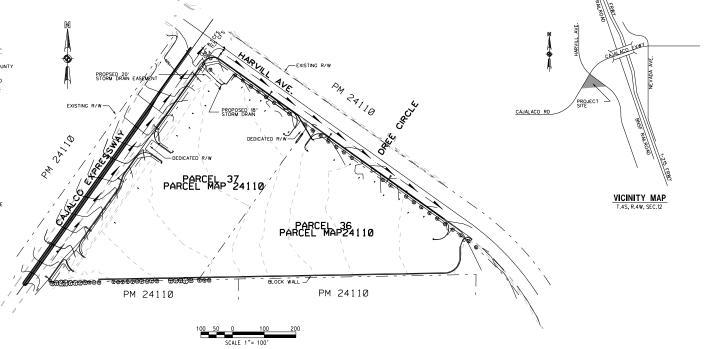

CONSTRUCTION NOTES

1. CONSTRUCT PER RIVERSIDE COUNTY STD. NO. 207A

(2) CONSTRUCT CURB AND GUTTER PER RIVERSIDE COUNTY STD. NO.200

3)CONSTRUCT MEDIAN PER RIVERSIDE COUNTY STD. NO 113

RECOMMENDED

4)CONSTRUCT 6" A.C. OVER 5" CLASS II A.B.

5. ADA RAMP PER RIVERSIDE CO. 403

6.REMOVE EXISTING DRIVEWAY
(7)SAW CUT LINE

(8,)PROPOSED EDGE OF PAVEMENT

4 EA 1000 LF 1860 LF

828 TONS OF A.C., 596 CY OF A.B.

4 EA 2EA 3EA

SEAL-ENGINEER

DATE

INDEX OF SHEETS: SHEET NO.(S)

300.03 1 2 3-4 DESCRIPTION
TITLE SHEET
TYPICAL SECTION
PLAN AND PROFILE
STORM DRAIN

Cot 2 till Working Days in Advance			
NOTE: WORK CONTAINED WITHIN THESE PLANS			
SHALL NOT COMMENCE UNTIL AN ENCROACHMENT PERMIT AND/OR A			
GRĀDING PĒRMIT HĀS BEEN ISSUED.			
THE PRIVATE ENGINEER SIGNING THESE PLANS IS RESPONSIBLE FOR ASSURING THE ACCURACY AND ACCEPTABILITY OF THE DESIGN HEREON IN THE EVENT OF			
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REVISIONS

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	CIVIL
	OF CALIFOR

APPR DATE

COUNTY

SEAL-COUNTY

DEPARTMENT OF TRANSPORT APPROVED BY:	ATION
KAHLED A, OTHMAN, P.E. CIVIL ENGINEER, R.C.E. NO. 33950	DATE


COUNTY OF DIVERGE

275 W. HOSPITALITY LINE SAN BERNARDINO, CALIFORNI PHONE: (909) 806-8000 FAX: (909) 806-8099		ELEVATI DATUM: DESCRIP LOCATIO WEST R	: 20A69 : CAL-TRANS ON: 1498.87 FEET, SEA LEVEL DATUM OF 1929 TION: CDH BRASS DISK N:IN CONCRETE, 4.5: WEST OF
PREPARED BY:	DATE	SCALE:	
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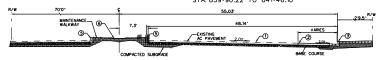
CONSTRUCTION NOTES

- EXISTING A.C. PAVEMENT TO REMAIN
 CONSTRUCT 6" A.C. OVER 5" CLASS II.A.B.
- 3 CONSTRUCT TYPE A-8, CURB AND GUTTER PER COUNTY OF RIVERSIDE STD, NO. 201
- 4 CONSTRUCT SIDEWALK PER COUNTY OF RIVERSIDE STD, NO. 401
- (5) CONSTRUCT TYPE "D", CURB PER COUNTY OF RIVERSIDE STO, NO. 204
- 6 CONSTRUCT LANDSCAPE MEDIAN PER COUNTY OF RIVERSIDE STD. NO. 113




CAJALCO EXPRESSWAY

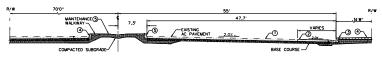STA. 835+80.80 TO 836+54.30 STA. 839+90.22 TO 841+46.10



CAJALCO EXPRESSWAY

STA. 837+36.71 TO 839+38.23

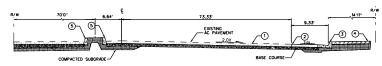


CAJALCO EXPRESSWAY

STA. 842+75.19 TO 843+93.27




HÅRVILL ÄVENUE


STA. 12+63.72 TO 13+06.23 STA 16+03.65 TO 16+45.79

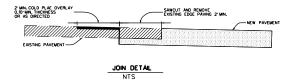




NOTE: WORK CONTAINED WITHIN THESE PLANS						SEAL-COUNTY	COUNTY OF RIVERSIDE		SEAL-ENGINEER	WILSON & COMPANY, INC. 275 W. HOSPITALITY LANE STE. 300 SAN BERNARDINO, CALIFORNIA 92408	BENCHMARK:	CUP3370	I.P. No. 040124 040124	SHEET NO.
SHALL NOT COMMENCE UNTIL AN ENCROACHMENT PERMIT AND/OR A GRADING PERMIT HAS BEEN ISSUED,						nahit SS/Au	DEPARTMENT OF TRANSPOR APPROVED BY:	ATION	got Esque	SAN BERNARDINO, CALIFORNIA 92408 PHONE: (909) 806-8000 FAX: (909) 806-8099	NUMBER: 20A69 AGENCY: CAL-TRANS FLEVATION: 1498 87 FFFT		OUNTY OF RIVERSIDE	2
THE PRIVATE ENGINEER SIGNING THESE PLANS IS RESPONSIBLE FOR ASSURING THE ACCURACY AND ACCEPTABILITY OF						AND A DORAN CE		DATE	82 55 1 STONE OF SE		DATUM: SEA LEVEL DATUM OF 1929 DESCRIPTION: COH BRASS DISK LOCATION: IN CONCRETE, 4.5' WEST OF WEST R/W FENCE, 23.2' EAST OF EAST RALL BUR, 0.7', DIS, MI SOUTH OF	TYPIC	CAL SECTIONS	оғ <u>5</u> sнтs.
DISCREPANCIES ARISING AFTER COUNTY APPROVAL OR DURING CONSTRUCTION, THE PRIVATE ENGINEER SHALL BE						Ma CE 33950 #	KAHLED A, OTHMAN, P.E. CIVIL ENGINEER, R.C.E. NO. 33950	DATE	No066576		RAIL, BUR. 0.7°, 0.19 MI SOUTH OF RAMONA EXPRESSWAY	FOR:	W.O. COUNTY FILE NO.:	1
RESPONSIBLE FOR DETERMINING AN ACCETABLE SOLUTION AND REVISING THE PLANS FOR APPROVAL BY THE COUNTY.	DATE	BY	MARK		APPR DATE	CIVIL			CIVILAND	PREPARED BY: DATE	SCALE:	1		
COUNTY.		ENGINE	ER	REVISIONS	COUNTY	OF CAUTO	RECOMMENDED	DATE	W LAND	KHIN M. HWAN 7-30-04				

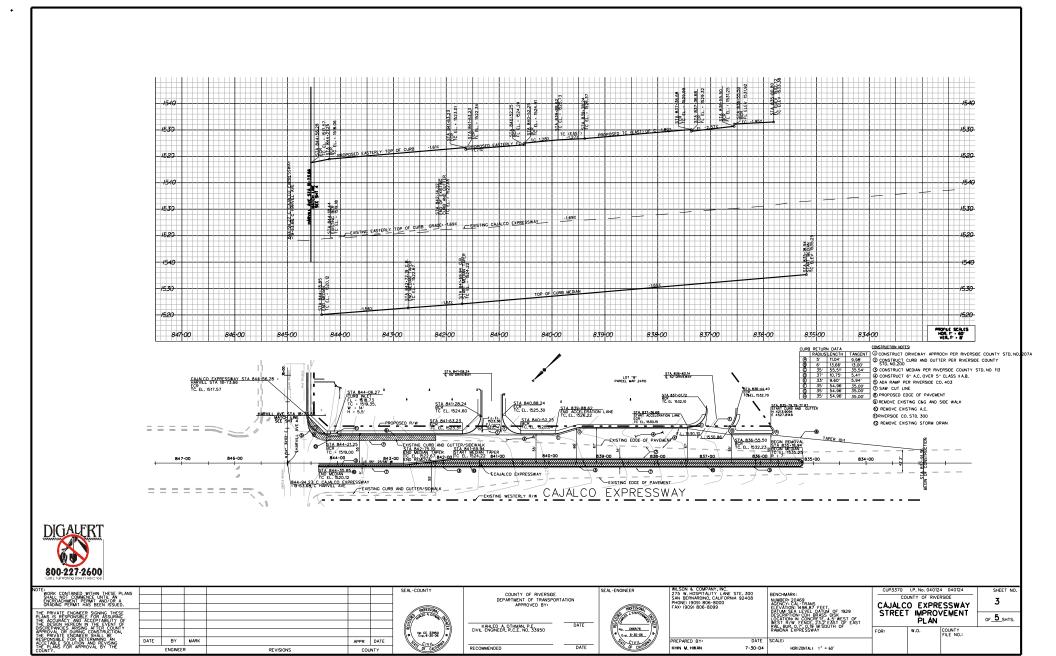

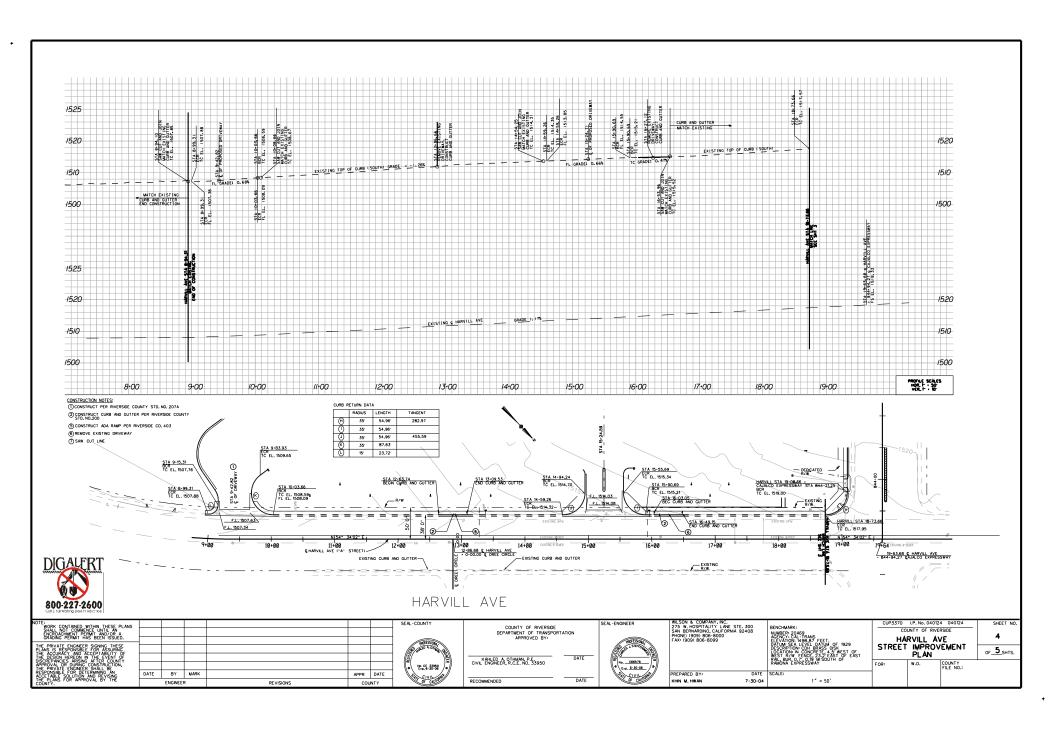

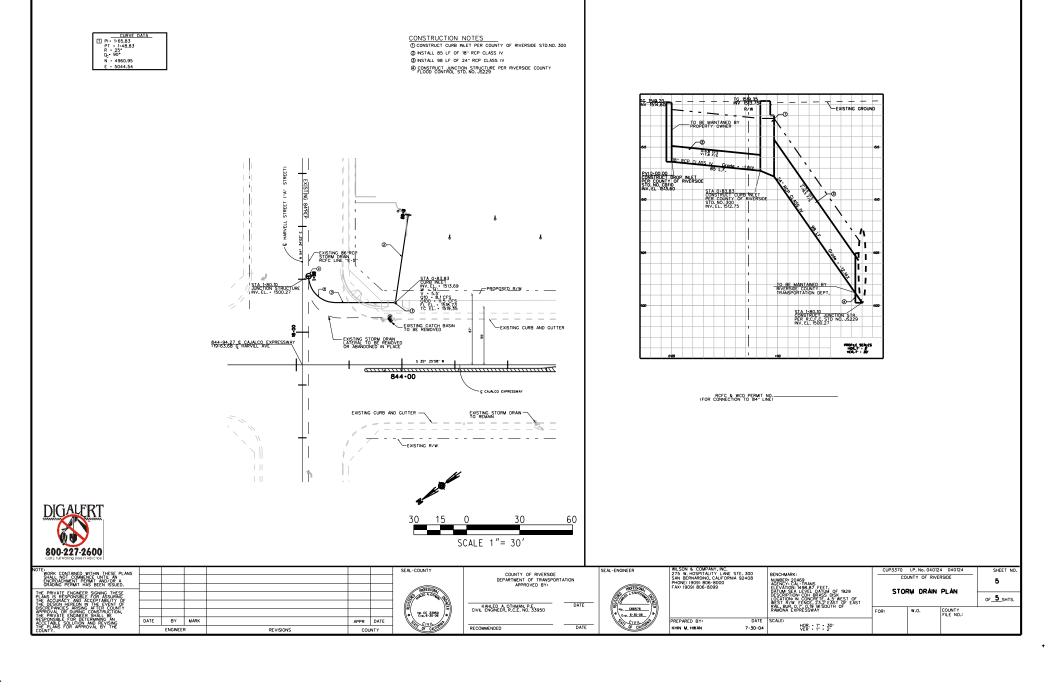

RIVERSIDE COUNTY TRAVEL ZONE GRADING PLAN CUP 03370

CAJALCO EXPRESSWAY AND HARVILL AVENUE

GRADING NOTES

- (1) ALL GRADING SHALL CONFORM TO THE UNIFORM BUILDING CODE, APPENDIX CHAPTER 33
- 2 ALL PROPERTY CORNERS SHALL BE CLEARLY DELINEATED IN THE FIELD PRIOR TO COMMENCEMENT OF ANY CONSTRUCTION/GRADING
- 4) DUST SHALL BE CONTROLLED BY WATERING OR OTHER APPROVED METHODS.
- NO FILL SHALL BE PLACED ON EXISTING GROUND UNTIL THE GROUND HAS BEEN CLEARED OF WEEDS, DEBRIS, TOPSOIL AND OTHER DELETERIOUS MATERIAL.
- MAXIMUM CUT AND FILL SLOPE = 2:1.
- STABILITY CALCULATIONS WITH A FACTOR OF SAFETY OF AT LEAST ON AND FIVE TENTH (1.5) SHALL BE SUBMITTED BY A SOILS ENGINEER TO THE BUILDING AND SAFETY DEPARTMENT FOR CUT AND FILL SLOPES OVER 30'IN VERTICAL HEIGHT.
- 8 PROVIDE 5' WIDE BY 1'HIGH BERM OR EQUIVALENT ALONG THE TOP OF ALL FILL SLOPES OVER
- (9) PROVIDE A BROW DITCH, DESIGNED TO HANDLE THE 100YR Q STORM FLOWS, ALONG THE TOP OF CUT SLOPES.
- "NO OBSTRUCTION OF FLOOD PLAINS OR NATURAL WATER COURSES SHALL BE PERMITTED.

- (1) "NO DESTRUCTION OF FLOOD PLANS OR NATURAL WATER COURSES SHALL BE PREMITED."

 2) ALL EXSTRUCTION OF PLANSE COURSES ON THE SIZE MAST CONTINUE TO FUNCTION. SEPCIALLY
 DIRING STORM COMOTIONS, ROTECTIVE MEASURES AND TEMPORARY DEMANDE PROVISIONS
 MAYS BE USED TO PROTECT ADJOINNOR PROPERTY DURING ROTEMAN OF PROVISIONS.

 (3) FINSH GRADE SHALL BE SLOPED MANY FROM ALL EXTERIOR WALLS AT NOT LESS THANYS.
 PER FOOT FOR A MINIMUM OF 3.

 (4) CLIT AND FLL SLOPES EQUAL TO GREATER THAN 3'IN VERTICAL HEIGHT SHALL BE PLANTED
 WITH GRASS OR GROUND COVER TO PROTECT THE SLOPE FROM EROSION AND INSTABILITY
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- APPROPRIATE BACKFLOW DEVICE PER UPC CHAPTER 10.

 ALL GRADNS, SALL, BE DONE IN CONFORMANCE WITH RECOMMENDATIONS OF THE PRELIMINARY FOR THE PROPRIEST OF THE PRESENCE OF THE PROPRIEST OF THE PROPR

- FINAL COMPACTION REPORTS WILL BE REQUIRED FOR ALL FILLS GREATER THAN 15

- THE CONTRACTOR SHALL NOTEY THE DISTRICT BUILDING AND SAFETY DEPARTMENT AT LEAST 24 HOURS IN ADVANCE REQUESTING FRASH GRADE AND DRANAGE MISPECTION. THIS INSPECTION MUST BE APPROVED PROR TO BUILDING FERMIT FORM. SPECTION FOR EACH LOT.
- (4) CONTRACTOR SHALL NOTIFY UNDERGROUND SERVICE ALERT, TWO DAYS BEFORE YOU DIG AT 1-800-422-4133.

PAVING NOTES

- MINIMUM PARKING LOT CRADE SHALL BE 17
- 2. MINIMUM GRADE FOR RIBBON DRAINS SHALL BE 0.35%.
- AN APPROVED SOIL STERILIZER SHALL BE USED ON ALL SUBGRADE SURFACES PRIOR TO PLACEMENT OF PAYING
- 4. ASPHALTIC EMULSION (FOG SEAL) SHALL BE APPLIED NOT LESS THAN FOURTEEN DAYS FOLLOWING PLACEMENT OF THE ASPHALT SURFACING, FOG SEAL AND PAINT BINDER SHALL BE APPLIED AT A RATE OF 0.05 AND 0.03 GALLONS PER SQUARE YARD RESPECTIVELY, ASPHALT EMULSION SHALL CONFORM TO SECTIONS 37, 39 AND 94 OF THE STATE STANDARDS AND SPECIFICATIONS.
- THE SUBDIVIDER OR CONTRACTOR SHALL APPLY TO THE RIVERSIDE COUNTY ROAD DEPARTMENT FOR AN ENCROACHMENT PERMIT FOR ALL WORK WITHIN COUNTY RIGHT-OF-
- TWO SPECIAL INSPECTIONS ARE REQUIRED BY THE BUILDING AND SAFETY DEPARTMENT. ONE INSPECTION AT THE TIME THE BASE IS PLACED AND THE SECOND WHEN THE A.C. OR CONNECTE HAS BEEN PLACED.

 THE CONTRACTOR SHALL BE RESPONSIBLE FOR THE CLEARING OF THE PROPOSED WORK ARE A.M. OR ELOCATION COSTS OF ALL EXISTING UTUITIES. REMITTEE SHALL HAVIORN THE COUNTY OF CONSTRUCTION SCHEDULED AT LEAST 48 HOURS PRIOR TO BEDINNING CONSTRUCTION.
- A COMPACTION REPORT BY A SOILS ENGINEER SHALL CERTIFY 95% COMPACTION OF BASE FOR A.C. AND 90% COMPACTION FOR CONCRETE PRIOR TO CALL FOR SECOND INSPECTION AND PLACEMENT OF ASPHALT CONCRETE AND CONCRETE PAVING.
- IF NO PRELIMINARY SOILS REPORT IS PROVIDED SPECIFYING THE PAVING SECTION, THE STRUCTURAL SECTION SHALL BE THREE INCHES ASPHALT CONCRETE AND FOUR INCHES CLASS ILAGOREGATE BASES.

**NOTE: FURNISH DUANTITY OF PAVING MATERIAL AS FOLLOW: A.C. (TONS): 1,058 BASE (TONS): 1,058 CONCRETE (CUBIC YAROS): 744 LANGSCAPINE (SQUARE FEET): 73,152

BENCHMARK

NUMBER: 20A69
AGENCY: CAL-TRANS
ELEVATION: 1498.87 FEET.
DATUM: SEA LEVEL DATUM: OF 1929
DESCRIPTION: ODH BRASS DISK
LOCATION: IN CONCRETE, 4.5 WEST OF
WEST RIM: FENCE, 23,2 EAST OF EAST
RAIL, BUR. 0.7. 0.19 M/SOUTH OF
RAMONA EAPRESSWAY.

OWNER

ENGINEER

KHIN HWAN, EIT WILSON & CO. 275 W. HOSPITALITY LANE SUITE 300 SAN BERNARDINO, CA. 92408 (909) 806-8000

GEOTECHNICAL ENGINEER

GHAYASUDDIN A. KHAN, P.E. GEO-E IKA, INC. 739 N. MÁIN STREET ORÁNGE, CALIFORNIA 92868 (714) 771-1278

ABBREVIATIONS

DATE

W. HOSPITALITY LANE STE. 300 BERNARDINO, CALIFORNIA 92408 NE. (909) 806-8090 (909) 806-8099

SAN PHON FAX:

[±]

SYMBOLS

CROSS SECTION GRATE INLET NORTH

> RETAINING WALL CONCRETE

NY//AY//AN

CALL OUT

SID1.00%

Q

LIGHT POLE

UNDERGROUND PVC


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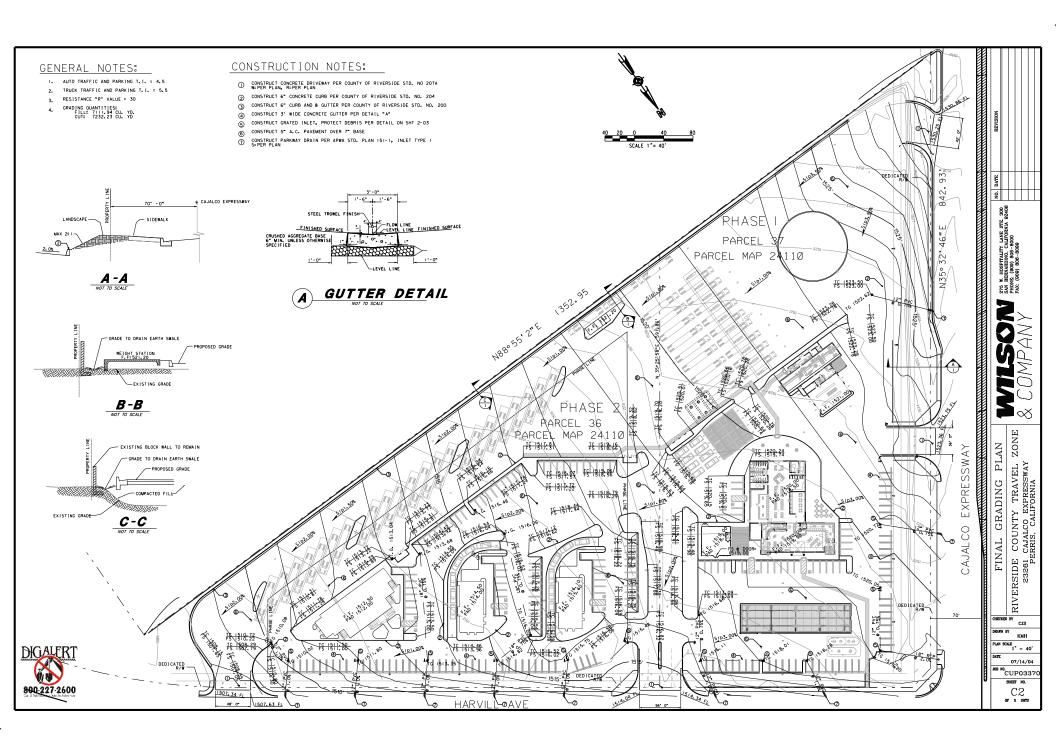
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RIVERSIDE 23261 CJS 07/14/04 [®]. CUP0337

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BEST MANAGEMENT PRACTICES FOR CONSTRUCTION ACTIVITIES

- A. ERDOED SEDIMENTS AND DIHER POLUTANTS MUST BE RETAINED ON SITE ON MAY NOT BE TRANSPORTED FROM THE SITE VIA SWALES. AREA DRAINS. OR MARRAL DRAINAGE COUNTSES.

 B. STOCKPILES OF EARTH AN DIHER CONSTRUCTION RELATED MATERIALS MUST BE PROJECTED FROM BELING TRANSPORTED FROM THE SITE BY THE FORCES OF
- WIND OR WATER.
- C. ULLES OILS SOLVENTS AND DIMES TOXIC MATERIALS MUST BE STORED IN ACCORDANCE WITH THER LISTIMG AND ARE MOIT OF CONTAININET THE SOIL AND SURFACE MATERS. ALL APPROVED STORAGE CONTAINERS ARE TO BE PROTECTED FROM THE WATHER. SPILLS MUST BE CLEAMED UP IMMEDIATELY AND DISPOSED OF IN A PROPER MANNER. SPILLS MAY NOT BE WASHED INTO THE WASHED INTO THE WASHED INTO THE WASHED INTO THE WASHED WA
- D. EXCESS OR WASTE CONCRETE MAY NOT BE WASHED INTO THE PUBLIC WAY OR ANY OTHER DRAINAGE SYSTEM. PROVISIONS SHALL BE MADE TO DRAIN CONCRETE WASTES ON SITE UNTIL THEY CAN BE DISPOSED OF AS SOLID WASTE.
- E. TRASH AND CONSTRUCTION RELATED DEBRIS MUST BE DEPOSITED INTO A COVERED RECEPTACLE TO PREVENT CONTAMINATION OF RAINWATER AND DISPERSAL BY WIND.
- F. SEDIMENTS AND OTHER MATERIALS MAY NOT BE TRACKED FROM THE SITE BY VEHICLE TRAFFIC. THE CONSTRUCTION ENTRANCE ROADWAYS MUST BE STABILIZED SO AS TO INHIBIT SEDIMENTS FROM BEING DEPOSITED INTO THE
- G. ANY SLOPES WITH DISTRUBED SOILS OR DENUDED OF VEGETATION MUST BE STABILIZED SO AS TO INHIBIT EROSION BY WIND AND WATER.
- H. ALL STABILIZATION PRACTICES REQUIRED TO PREVENT DISCHARGE OF SEDIMENT FROM THE SITE MUST BE INSTALLED PRIOR TO ANY EARTH MOVING ACTIVITIES.

MAINTENANCE AND INSPECTION PROCEDURES

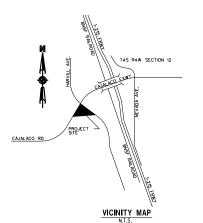- THE CONTRACTOR SHALL INSPECT THE EROSION AND SEDIMENT CONTROL .MEASURES EVERY FOURTEEN (14) CALENDAR DAYS AND WITHIN 24 HOURS OF THE END OF A STORM THAT IS 0.5 INCHES OR GREATER.
- 2. THE CONTRICTOR SHALL WANTAIN A "DOLLTION PREVENTION BLAN (PPP)
 INSPETTION AND MAINTENANCE REPORT AT ALL IT HES DRINN THE CONTROLTION.
 EACH INSPECTION OF ERRISION AND SEDIMENT CONTROL MEASURES SHALL GE
 DOCUMENTED BY THE CONTRACTOR ON THE INSPECTION FORM REVOYEDE BY THE
 PROJECT MANAGER. THE COPIES OF THE COMPLETED FORMS SHALL GE SUBMITTED
 TO THE PROJECT MANAGER WITHIN 48 HOURS AFTER EACH INSPECTION.
- 3. THE CONTRACTOR SHALL REPAIR ANY EROSION AND SEDIMENT CONTROL MEASURES WITHIN THREE (3) DAYS FOLLOWING THE INSPECTION DURING WHICH DAMAGE IS NOTEO OR FOLLOWING NOTIFICATION BY THE PROJECT MANAGER THAT REPAIRS ARE REQUIRED.
- 4. REPAIRS SHALL BE INITIATED WITHIN TWENTY FOUR (24) HOURS OF DAMAGE OCCURRING TO THE EROSION CONTROL MEASURES THAT COULD RESULT IN A DISCHARGE OF SEDIMENTS INTO A LIVE STREAM, WATER IMPOUNDMENT, AND OTHER NEARBY BODIES OF WATER, AS DIRECTED BY THE PROJECT.
- 5. ALL TEMPORARY EROSION AND SEDIMENT CONTROL MEASURES SHALL BE MAINTAINED BY CLEANING OR REPLACING AS NEGDED. AS DIRECTED BY THE PROJECT MANAGER. SO AS TO BE FULLY EFFECTIVE UNTIL PERMANENT EROSION CONTROL MEASURES ARE IN PLACE AND OPERATIONAL.
- THE CONTRACTOR SHALL MAINTAIN A COPY OF THE PERMIT REGULATION PROVIDED BY THE PROJECT MANAGER.


STABILIZATION PRACTICES INTERIM STABILIZATION:

- ALL EXPOSED SOIL AREAS WITHIN THE PROJECT LIMITS SHALL BE TREATED WITH TEMPORARY SOIL STABLANT TO PREVENT EROSION AND KEEP THE AREA DUST-FREE AS MUCH AS PRACTICABLE.
- THE CONTRACTOR SHALL USE WATERING EQUIPMENT FOR DUST POLLUTION ABATEMENT. THIS OPERATION SHALL BE GIVEN PRIORITY OVER ANY OTHER OPERATION WHERE EQUIPMENT MIGHT BE NEEDED.
- 3. PITS. HAUL ROADS. AND ALL OTHER AREAS OCCUPIED BY THE CONTRACTOR SHALL BE KEPT FREE OF DUST AS MUCH AS PRACTICABLE.

GENERAL NOTES

- CONTRACTOR SHALL BE RESPONSIBLE FOR INSPECTIONS AND MAINTENANCE OF BEST MANAGEMENT PRACTICES (BMP).

- THE CONTRACTOR SHALL INSURE THAT NO SOIL ERODES FROM THE SITE INTO PUBLIC ROW OR ON TO PRIVATE PROPERTY.
- THE CONTRACTOR SHALL ENSURE THAT THE EROSION CONTROL MEASURES OUTLINED ON THIS SHEET ARE ADHERED TO DURING AND AFTER CONSTRUCTION.

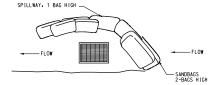

TYPICAL PROTECTION FOR INLET ON GRADE

2. SOLID AND HAZARDOUS WASTE SHALL BE HANDLED AND STORED IN ACCORDANCE WITH APPLICABLE FEDERAL. STATE AND LOCAL REGULATIONS AND ORDINANCES.

3. ALL BMPS SHALL BE CONSTRUCTED IN ACCORDANCE WITH THE PLAN SHOWN. DEVIATION FROM THIS PLAN SHALL BE MOTED AND RECORDED IN WEEKLY INSPECTION REPORTS WITHIN THE STORM WATER POLLUTION PREVENTION PLAN.

4. THE NPDES PERMIT FOR THE PROJECT. OR A COPY OF THE NOTICE OF INTENT (NOI) IF A FERMIT NUMBER HAS NOT BEEN ASSIONED, SHALL BE POSTED AT THE PROJECT SITE OR THE FIELD OFFICE AT ALL TIMES DURING CONSTRUCTION.

5. THE POLLUTION PREVENTION PLAN (PPP) AND ALL MAINTENANCE AND INSPECTION REPORTS SHALL BE SIGNED BY A DUAL FIED INSPECTOR ASSIGNED BY THE CONTRACTOR. THE PPP PACKAGE AND THE REPORTS SHALL BE AVAILABLE TO EPP REPRESENTATIVES AT ALL TIMES DURING CONSTRUCTION.

8. ALL REDUIREMENTS DUTLINED IN THE FEDERAL ENVIRONMENTAL PROTECTION AGENCY (EPA) NATIONAL POLITANT DISCHARGE ELIMINATION SYSTEM INDRESS SMALL BE STRICTLY ADMERED TO DURING THE COURSE OF CONSTRUCTION THIS PROJECT, EXPOSED AREAS OF DISTURBANCE SHALL BE KEPT TO A MINIMUM TO PERFORM PROJECT CONSTRUCTION AND SHALL BE PROTECTED BY THE OTHER SEDIMENT CONTROL OF STRICT BY STRICT BY THE OTHER SEDIMENT CONTROL OF STRICT BY THE ADMENTANCE ADMENTANCE ADMENTANCE ADMENTANCE AND AND ARE APPLEAD TO THE OTHER SEDIMENT CONTROL OF STRICT BY THE ADMENTANCE ASSETS.

DIGALERT Ø U 800-227-2600 SAN PHON FAX: \propto

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PLAN

CONTROL

DATE

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W. HOSPITALITY LANE STE. 300 BERNARDINO, CALIFORNIA 92408 NE. (909) 806-8000 (909) 806-8099

ZONI COUNTY TRAVEL CAJALCO EXPRESSWAY ERRIS, CALIFORNIA

EROSION /ERSIDE 23261 PE RIVI CJS

KMH PLAN SCALE 1" = 40'

07/14/04 "CUP0337

> СЗ OF 8 SHTS

GENERAL

- 1. WATERSYSTEM MAPROVEMENTS SHALL BE CONSTRUCTED BY THE DEVELOPER FOR DEDICATION TO WESTER MANUPER, WERE DISTRICT. CONSTRUCTION, MATERIAS, TESTING, AND INSPECTION SHALL COMPLY WITH WESTERN MUNICIPAL COMPLY WITH WESTERN MUNICIPAL COMPLEX WITH WESTERN MUNICIPAL COMPLEX FOR COMPLEXITY OF ALL PREMISE OFFICER FOR COMPLEXITY OF ALL PREMISE OFFICER CONTROL WATER WORKS ASSOCIATION (A.W.W.A.) STANDARDS, FALURE TO MEET THESE REQUIREMENTS WILL BE CAUSE FOR RELECTION.
- CONSTRUCTION OF THE WATER SYSTEM IMPROVEMENTS SHALL NOT COMMENCE UNTIL A FINAL MEPHAS DEEN RECORDERS, MERCOND COUNT NO THE DEVELOPER'S WATER PRELIMES SHALL BE INSTALL AFTER CONSTRUCTION OF DUB B CUTTER, SEWER, STORM DRAIN, AND PRIOR TO THE PLACEMENT OF CROSS-CUTTERS, SPANDRELS, AND PAINSE.
- PIPE, FITTINGS, VALVES AND APPURTENANCES SHALL BE OF THE PIPE PRESSURE CLASS (NOT W.P. CLASS) SHOWN ON THE PROFILE OF THESE PLANS, (NOTE: CAST IRON FITTINGS ARE NOT ALLOWED.
- . COVER OVER PIPE SHALL BE 36 INCHES FOR PIPELINES LESS THAN 12 INCHES IN DIAMETER AND 48" FOR PIPELINES 12" AND GREATER IN DIAMETER, WHEN THE WATER PRELINE ROCKOMITIES AN OBSTRUCTION AND COROSING OVER THE OBSTRUCTION WILL RESULT IN LESS THAN MINIOUS COVER, THE WATER PIPELINE SHALL CROSS UNDER THE OBSTRUCTION MINIOUS CELEBORY 20" CONTROL TO THE WATER PIPELINE SHALL CROSS UNDER THE OBSTRUCTION MINIOUS 22" CLEARWACE PIPELINE SHALL CROSS UNDER THE OBSTRUCTION MINIOUS 22" CLEARWACE PIPELINE SHALL CROSS UNDER THE OBSTRUCTION MINIOUS 22" CLEARWACE PIPELINE SHALL CROSS UNDER THE OBSTRUCTION MINIOUS 22" CLEARWACE PIPELINE SHALL CROSS UNDER THE OBSTRUCTION MINIOUS 22" CLEARWACE PIPELINE SHALL CROSS UNDER THE OBSTRUCTION OF THE OBSTRUC
- CONTRACTOR SHALL PROVIDE TERCH PROTECTION AND CONDUCT ALL
 CONSTRUCTOR SHALL PROVIDE TERCH PROTECTION AND CONDUCT ALL
 CONSTRUCTION IN ACCORDANCE WITH CAL-05HA REQUIREMENTS AND SHALL
 DETERMINE DEPTH AND LOCATION OF EXISTING UNDERGROUND FACILITIES PRIOR
 TO TRENCHING, O'PEN TERCH AT ANY ONE TIME SHALL BE LIMITED TO 500° ALONG
 ROW, RIGHT OF WAY. AND SHALL BE BLOCKLED AND COMPACTED AT THE
 1-800-227-2500 PRIOR TO ANY EXCAVATION.
- PIPE SHALL BE HANDLED SO AS TO PROTECT PIPE AT ALL TIMES AND SHALL BE CAREFULLY BEDDED TO PROVIDE CONTINUOUS BEARING AND TO PREVENT UNEVEX SETTLEMENT, PIPE SHALL BE PROTECTED AGAINST LOTATION AT ALL TIMES. OPEN ENDS SHALL BE SEALED AT ALL TIMES WHEN CONSTRUCTION IS NOT IN PROGRESS.
- TAPS ON PPELINE SHALL BE INSTALLED PER DISTRICT STANDARDS MAD AS APPROVED IN THE FELD BY MAND INSPECTOR. CONNECTIONS TO EXISTING MATERIAL PROPERTY OF THE PERSON WERE ASSETTED AS THE PROPERTY OF THE PERSON WERE DISTRICTS INSPECTOR IS PRESENT WERE FISHIN MAY ELECT TO MAKE THE CONNECTION. CONTRACTOR SHALL FIELD VERIFY BOTH HORIZONTAL MAD VERTICAL LOCATIONS OF EXISTING WATER PRIENCES PRIOR TO CONSTRUCTION.
- BACKFILL SHALL BE COMPACTED TO EITHER 90% RELATIVE DENSITY, EQUIVALENT TO THE SURROUNDING GROUND, OR IN ACCORDANCE WITH THE REQUIREMENTS OF THE AGENCY HAVING JURISDICTION, WHICHEVER IS MORE STRINGENT.
- . TEST PRESSURE SHALL BE 150% OF PIPE CLASS RATING (IE: CLASS 150-225 PSITEST), SHALL BE UNDER CONTINUOUS INSPECTION, AND SHALL BE IN ACCORDANCE WITH DISTRICT STANDARD PROCEDURES.
- 11. SURFACE IMPROVEMENTS DAMAGED AS A RESULT OF THE CONTRACTOR'S OPERATIONS SHALL BE RECONSTRUCTED BY THE CONTRACTOR TO THE REQUIREMENTS OF THE ACENCY HAVING JURISDICTION.
- 12. FIRE HYDRANTS AND AIR VALVES SHALL BE LOCATED PER AGENCY HAVING JURISDICTION.
- 13, WATER METERS SHALL BE LOCATED PER PLAN, ANY RELOCATION SHALL BE APPROVED BY WMWD. A """ SHALL BE IMPRINTED ON CURB FACE AT EACH SERVICE LATERAL (CATION.
- 14. CONTRACTOR SHALL PLACE 14 GA SOLID COPPER LOCATOR WIRE WITH ALL C-900 PVC PIPE TO ASSIST WITH FUTURE LOCATION.
- ANY REVISION TO THESE DRAWINGS MUST BE APPROVED IN WRITING BY WESTERN MUNICIPAL WATER DISTRICT.
- 17. THE CONTRACTOR IS ADVISED THAT THE WORK ON THIS PROJECT MAY INVOLVE WORKING IN A CONFINED AIR SPACE. CONTRACTOR SHALL BE RESPONSIBLE FOR COMPLIANCE WITH "CONFINED AIR SPACE" ARTICLE 108, TITLE 8 CALIFORNIA ADMINISTRATIVE CODE.
- ALL PIPE LARGER THAN 12" IN DIAMETER SHALL BE INSPECTED BY VIDEO CAMERA PRIOR TO BACTERIOLOGICAL TESTING.
- 19. ALL FIRE HYDRANTS SHALL BE COLOR CODED ACCORDING TO THE HYDRANT'S FLOW RATE AT A RESIDUAL PRESSURE OF 20 PSI ALL BARRELS SHALL BE CHROME YELLOW. CAP AND TOP COLORS SHALL BE AS FOLLOWS:

DATE BY MARK

ENGINEER

APPR DATE

COUNTY


REVISIONS

>1500 GPM: LIGHT BLUE; 1000 TO 1499 GPM: GREEN; 500 TO 999 GPM: ORANGE; <500 GPM: RED. HYDRANTS WITH PRESSURE OVER 100 PSISHALL BE LETTERED "H.P." ON THE BARREL IN A LOCATION VISIBLE TO THE STREET OR USE SIDE, ALL FIRE HYDRANTS SHALL BE "WET-BARREL".

20. CONTRACTOR SHALL WARRANTY ALL WORK FOR 12 MONTHS AFTER DATE OF FINAL INSPECTION.

RIVERSIDE COUNTY TRAVEL ZONE WATER IMPROVEMENTS CUP 03370

CAJALCO EXPRESSWAY AND HARVILL AVENUE

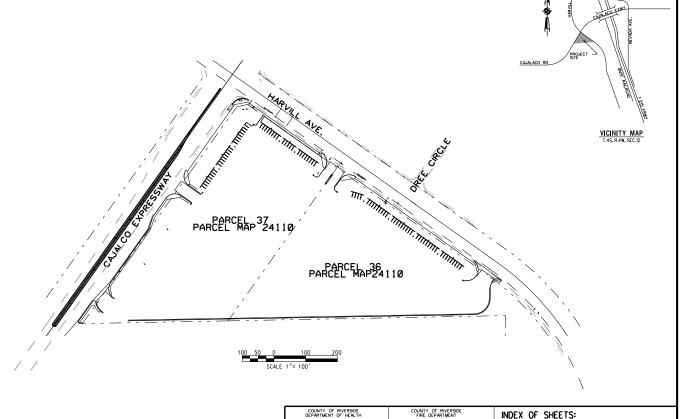




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AL-COUNTY	COUNTY OF RIVERSIDE DEPARTMENT OF TRANSPORTATION	SEAL-ENGINEER	WILSON & COMPANY, INC. 275 W. HOSPITALITY LANE STE. 300 SAN BERNARDINO, CALIFORNIA 92408	BENCHMARK:		I.P. No. 04012 IUNTY OF RIVE	
PROFESSIONAL SERVICE AND A COMPANY OF SERVICE ASSESSMENT OF SERVIC	APPROVED BY: KAHLED A OTHMAN, P.E. DATE	MOTES ON	PHONE: (909) 806-8000 FAX: (909) 806-8099	NUMBER: 20.469 AGNOY: CALI-TRANS ACGNOY: CALI-TRANS ACGNOY: CALI-TRANS ACGNOY: CALI-TRANS DATIAN-SEA LEVEL DATUM OF 1929 DESCRIPTION: COH BRASS DISK LOCATION: CONCRETE: 4.5 WEST OF EAST WEST R/W FENCE, 23.2 EAST OF EAST RAIL, BUR, 0.7; 0.19 MI SOUTH OF		LE SH	
₩ No CE 33950 #	CIVIL ENGINEER, R.C.E. NO. 33950	Mo. <u>C66576</u>		RAMONA EXPRÉSSWAY	FOR:	w.o.	COUNTY FILE NO.:
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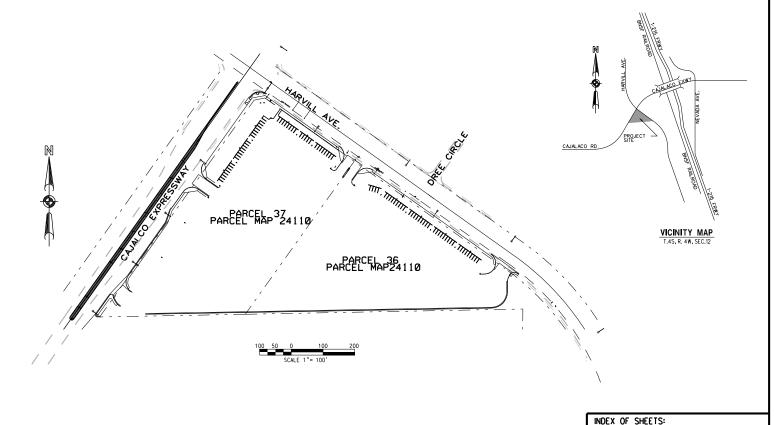
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RIVERSIDE COUNTY TRAVEL ZONE STREET LIGHT IMPROVEMENTS CUP 03370

CAJALCO EXPRESSWAY AND HARVILL AVENUE





SEAL-COUNTY

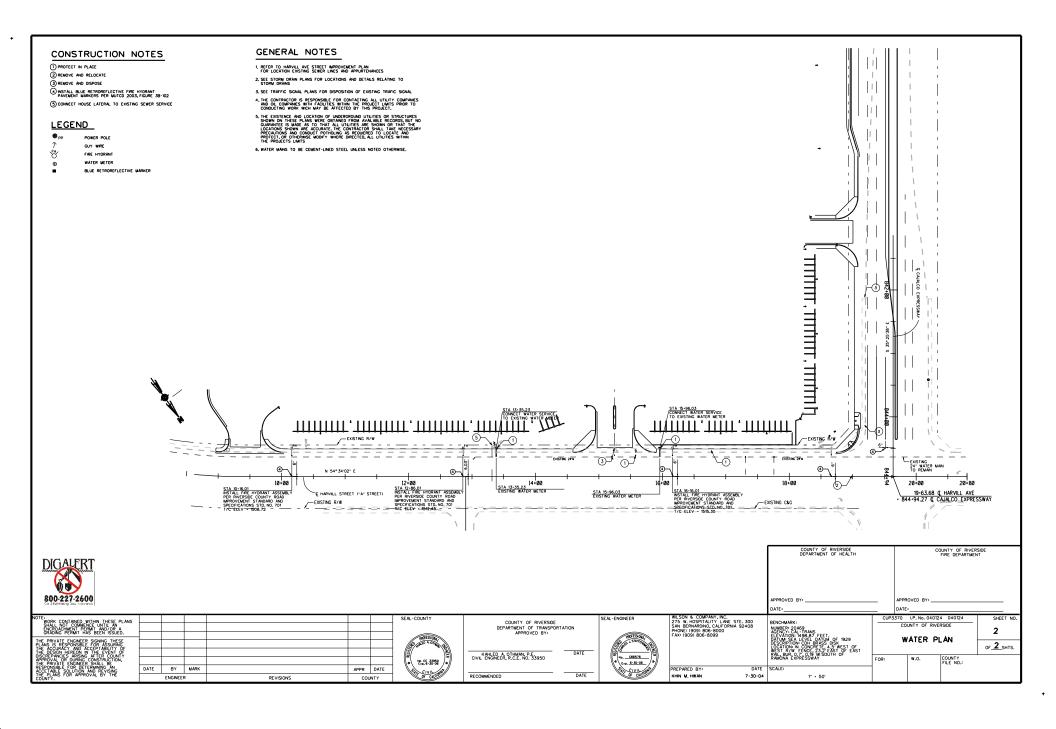COUNTY OF RIVERSIDE
DEPARTMENT OF TRANSPORTATION
APPROVED BY:

KAHLED A, OTHMAN, P.E.
CIVL. ENGREER, R.C.E. NO. 39950

100 ESO QUE 100 E WILSON & COMPANY, NC. 275 W. HOSPITALITY LAWE STE. 300 SAN BERNARDINO, CALIFORNIA 92408 PHONE: 1909) 806-8000 FAX: (909) 806-8099

7-30-04

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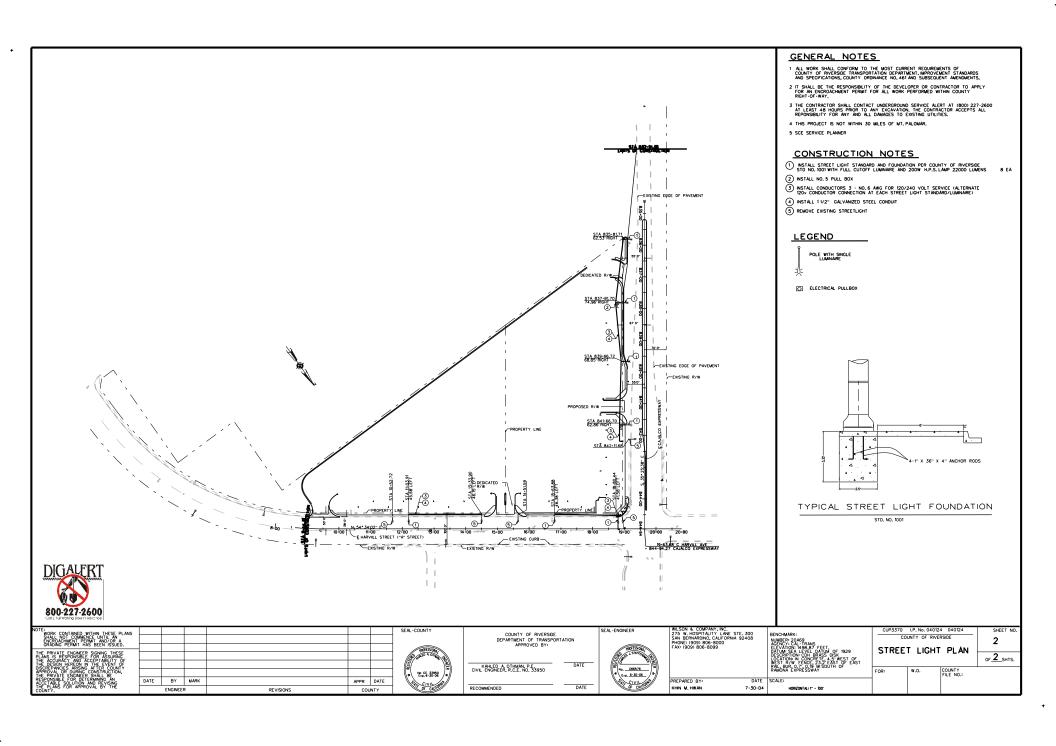
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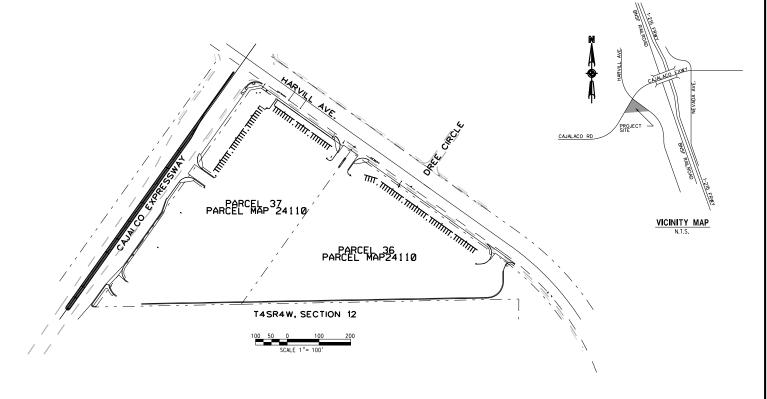
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RIVERSIDE COUNTY TRAVEL ZONE STRIPING AND SIGNAGE CUP 03370

CAJALCO EXPRESSWAY AND HARVILL AVENUE






INDEX OF SHEETS:

SHEET NO.(S) DESCRIPTION

I TITLE SHEET

2 STRIPING AND SIGNAGE PLAN

NOTE: WORK CONTAINED WITHIN THESE PLANS							SEAL-COUNTY	COUNTY OF RIVERSIDE		SEAL-ENGINEER	WILSON & COMPANY, INC. 275 W. HOSPITALITY LANE STE. 300	BENCHMARK:				SHEET NO.
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APPROVAL OR DURING CONSTRUCTION, THE PRIVATE ENGINEER SHALL BE							₩ No CE 33950 /#/	CIVIL ENGINEER, R.C.E. NO. 33930		#\Exp. 5-30-06 /#/		NAMED OF THE STATE	F OR:	w.o.	FILE NO.:	
ACCETABLE SOLUTION AND REVISING	DATE	BY	MARK		_	DATE	CIVIL	l 	DATE	SI CIVIL DOM		SCALE: HORIZONTAL: 1"=1"				
COUNTY.		ENGINE	R	REVISIONS	cc	UNTY	OF CALIFO	RECOMMENDED	DATE	U CAS	KHIN M, HWAN 7-30-04					

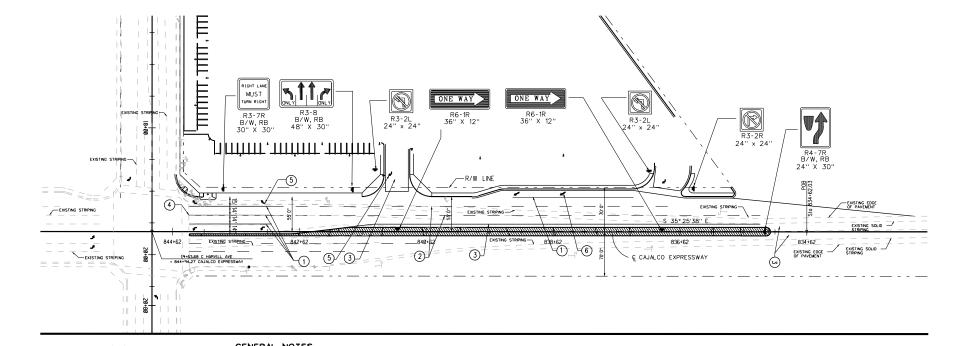

CONSTRUCTION NOTES

- 1 PAINT SOLID WHITE STRIPE PER CALTRANS STD A20D, DETAIL 38A, W . 4".
- PAINT DASHED WHITE STRIPE PER DETAIL PER CALTRANS STD A20A, DETAIL 8, W 4", LENGTH OF STRIPE 10', LENGTH OF GAP 30',
- (3) PAINT SOLID DOUBLE YELLOW LINE PER CALTRANS STD A208, DETAIL 28, W . 4".
- (4) APPLY/REAPPLY THERMIPLASTIWHITE SOLID CROSSWALK STRIPE, W · 8".
- 5) APPLY THERMOPLASTIC TURN LANE PAVEMENT MARKING ARROW PER CALTRANS STD A24A, TYPE IV
- 6 APPLY THERMOPLASTIC LANE REDUCTION PAVEMENT MARKING ARROW PER CALTRANS STD A24A, TYPE VI.

GENERAL NOTES

- TRAFFIC STRIPES, PAVEMENT MARKINGS, AND RAISED PAVEMENT MARKERS PER
 CALTRANS TRAFFIC MANUAL, STANDARD PLANS AND SPECIFICATIONS, LATEST EDITION.
- ALL SIGNS SHALL BE STANDARD SIZE UNLESS OTHERWISE NOTED ON PLANS, SIGNS SHALL BE INSTALLED ON 4"X4" WOOD POST WITH ANCHOR BLOCKS UNLESS OTHERWISE NOTED ON THE PLAN.
- NOTED ON THE PURPLY STATEMENT MARKINGS SHALL BE REFLECTORIZED. STENCES FOR PAVENERT MARKINGS SHALL BE MATCH COUNTY FERERAL METRIC STANDARD STENCES EXACTLY. ALL STRIPING AND MARKING DETAILS SHALL MATCH CALTRANS STANDARD PLANS DETAILS.
- A ALL CONFLICTION STRIPES AND PAVEMENT MARKINGS SHALL BE REMOVED BY SAMBE ASTRIC OR GROUNG, CONFLICTING SIGNS AND RAISED PAVEMENT MARKERS SHALL BE REMOVED, ALL REMOVES OF SIGNS AND MARKINGS SHALL BE RESPONSIBILITY OF THE DEVELOPER OR APPLICANT,
- PANTED TRAFFIC STRIPES AND PANTED PAVEMENT MARKINGS (IF ALLOWED) SHALL BE APPLIED IN TWO COATS. PAVEMENT MARKINGS SHALL BE APPLIED IN THERMOPLASTIC FORMAT UNLESS APPROVED OTHERWISE.
- 6. LL TEMPOYED DOES DAN BE SALVADO AND DELIVERED TO THE COUNTY AND A DESCRIPTION OF THE COUNTY INSPECTION OF THE COD STIT.

 7. THE COUNTY MEXILLS DOES, AND PARTICI DIESE, MEXILLATEN OF SCHOOL AND DISPRESS DANLE OR ACCORDING WITH THE PROPRIOR OF AN WHITH ALL MICKERED COSTS GOTHER OF THE DEVELOPER/PRICART. THE CONTRACTOR. THE RIGHT TO ROBURE ALL HOWS TO BE DONE OF THE COUNTRACTOR.
- 8. RASED PAYLENT MARKETS SHALL BE FUNDED AND MISLAGED BY THE CONTRACTOR IN ACCORDANCE WITH THE STREPPING DETAILS SHOWN ON THE SIGNING MO STREPPING PLAN INSTALLATION SHALL BE COMPLETE WITHIN DAYS OF RODOWN STREPPING. RASED PAYLENT MARKETS ARE TO BE INSTALLED ON RODOWN STREPPING. RASED PAYLENT MARKETS ARE TO BE INSTALLED ON RODOWN STREPPING. RASED PAYLENT MARKETS ARE TO BE INSTALLED.







NOTE: WORK CONTAINED WITHIN THESE PLANS SHALL NOT COMMENCE UNTIL AN ENCROACHMENT PERMIT AND/OR A GRADING PERMIT HAS BEEN ISSUED.					SEAL-COUNTY	COUNTY OF RIVERSIDE DEPARTMENT OF TRANSPORTATION APPROVED BY:	SEAL - ENGINEER	WILSON & COMMANY, INC. 275 W. HOSPITALITY LANE STE. 300 SAN BERNARDINO, CALIFORNIA 92408 PHONE: (909) 806-8090 FAX: (909) 806-8099	BENCHMARK: NUMBER: 20.469 AGENCY: CAL-TRANS ELEVATION: 1498.87 FFET.	co	I.P. No. 040124 JUNTY OF RIVER	RSIDE	5-02
THE PRIVATE ENGINEER SIGNING THESE PLANS IS RESPONSIBLE FOR ASSURING THE ACCURACE AND ALCEPTABLE TO FOR DISCREPANCES ARRIVED AFTER COUNTY APPROVAL OR THINKS CONSTRUCTION					TO A OR A SECOND	KAHLED, A. OTHMAN, P.E. DATE	- C151070000		DATUM: SEA LEVEL DATUM OF 1929 DESCRIPTION: COM BRASS DISK LOCATION: IN CONCRETE, 4.5 WEST OF WEST R/W FENCE, 22.2 EAST OF EAST RAIL, BUR, 0,7, 0,19, MISOUTH OF	Ši	SNAGE PL	.ÃN	OF. <u>2</u> SHTS.
APPROVAL OR DURING CONSTRUCTION, THE PRIVATE ENGINEER SHALL BE	DATE BY ENGINEER	MARK	REVISIONS	APPR DATE	# 100 CE 150000 #	CIVIL ENGINEER, R.C.E. NO. 33950 RECOMMENDED DATE	(crp. 6-30-06)*	PREPARED BY: DATE KHIN M, HWAN 7-30-04	SCALE: HORIZONTAL: 1" - 50"	FOR:	w.o.	COUNTY FILE NO.:	